


90 FIFTH ST. SPRECKELS, CA 93962

FIFTH STREET

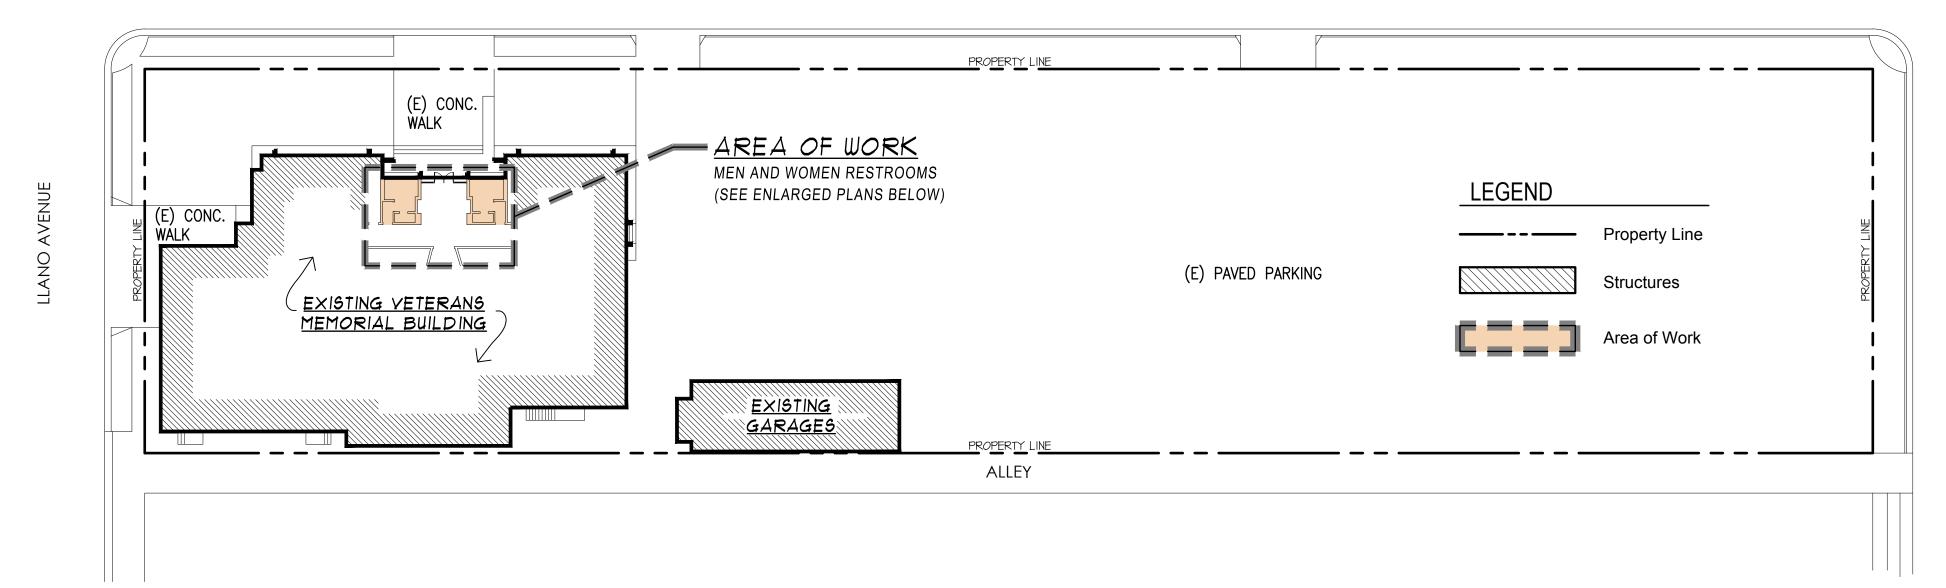


# DISCLAIMER:

THE PROPERTY LINE LAYOUT (DIMENSIONS, ORIENTATION AND LOCATION) WERE PRODUCE FROM ASSESSOR MAPS. THESE MAPS DO NOT REPRESENT ACTUAL SURVEYS AND ARE ONLY USED FOR SCHEMATIC

THE DIMENSIONS PROVIDED ON THE PLANS ARE A RESULT OF FIELD OBSERVATIONS, AND WERE TAKEN FROM ASSUMED PROPERTY LINES. IF AN ACCURATE SURVEY IS REQUIRED; THE SURVEY SHALL BE PERFORMED BY A COMPETENT LAND SURVEYOR CURRENTLY LICENSED IN THE STATE OF CALIFORNIA.



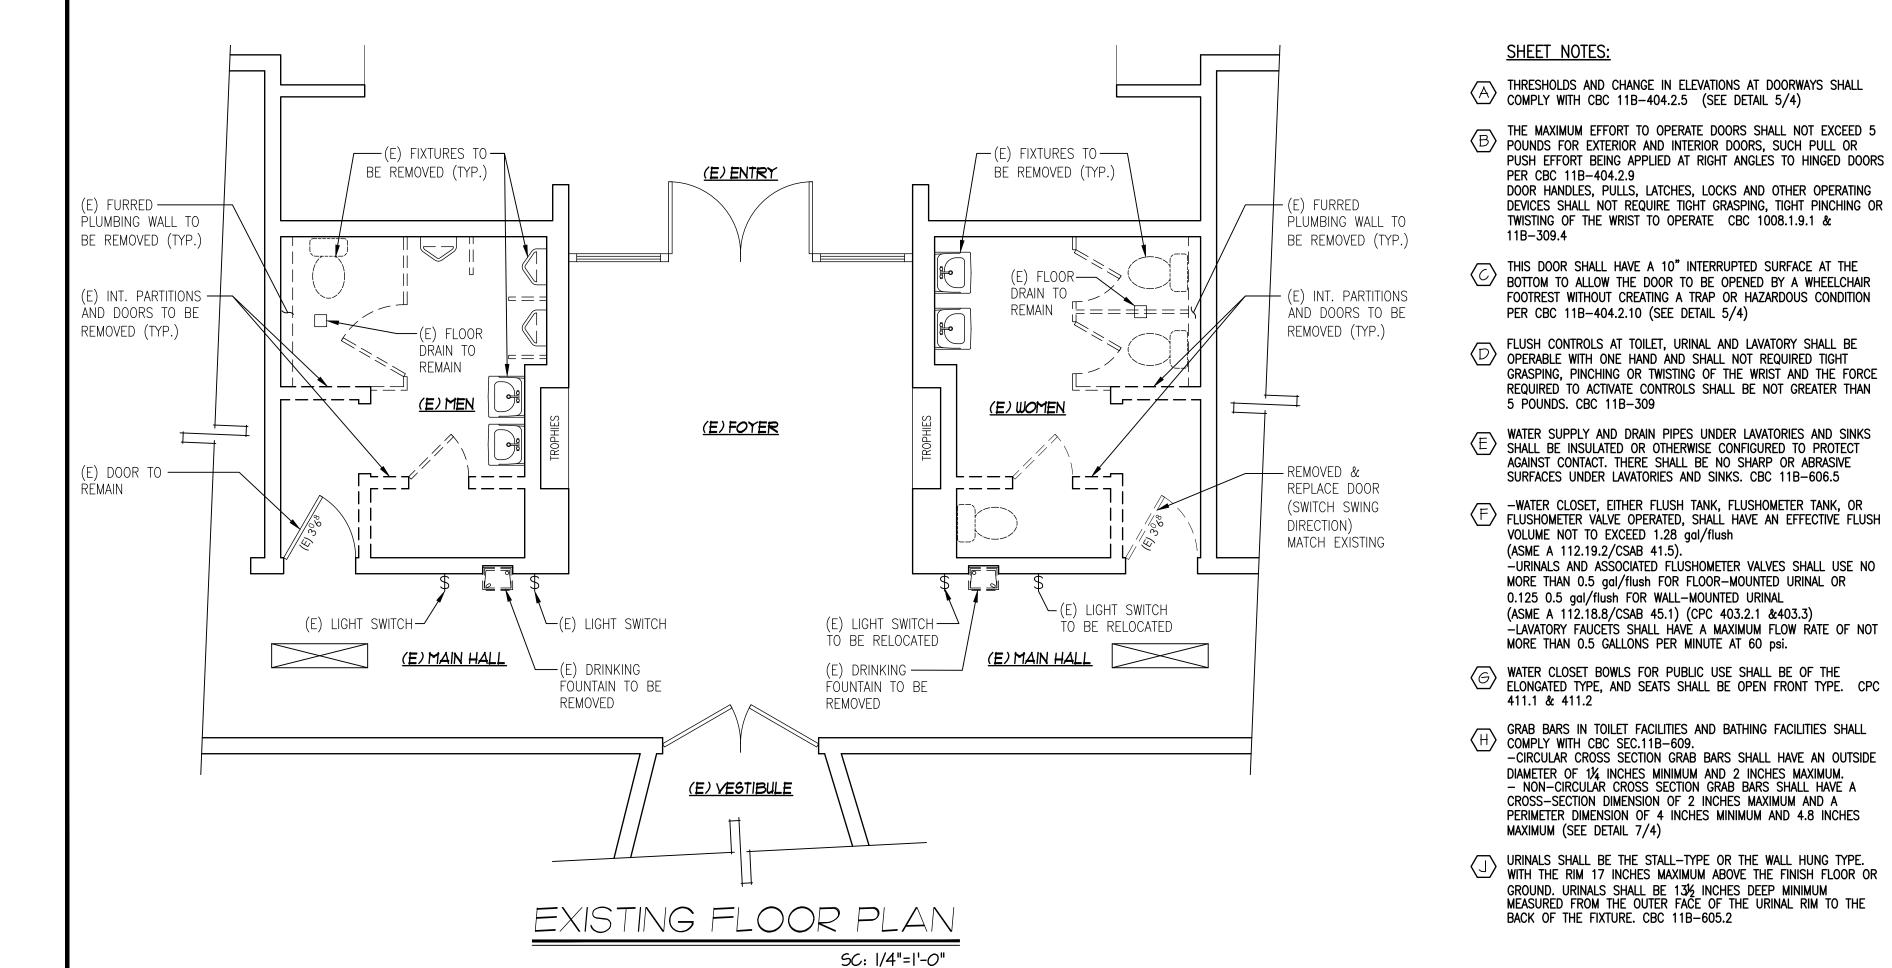


# DRAWING INDEX

COVER SHEET / PROJECT DATA LIST OF GREEN MEASURES EXISTING & PROPOSED FLOOR PLANS ELECTRICAL NOTES

ELECTRICAL PLAN & FIXTURE / EQUIPMENT PLAN

PLUMBING PLAN ACCESSIBILITY SIGNS & DETAILS

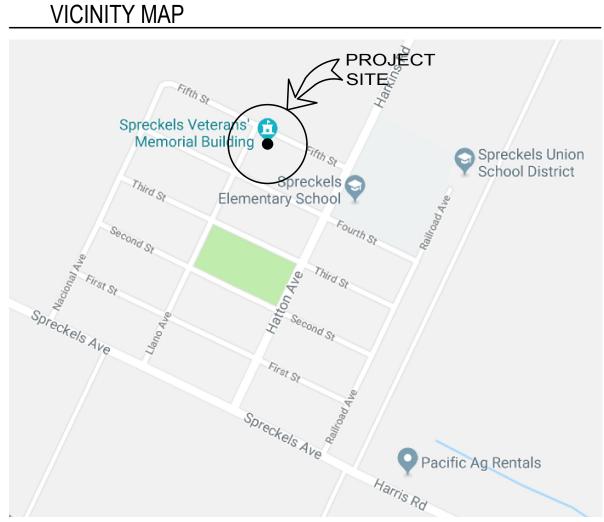

#### DRAWN BY:

DEREK JOHNSON, P.E. CENTRAL COAST ENGINEERS, INC. 21 W. ALISAL STREET, SUITE 119 SALINAS, CA 93901 Phone (831) 757-5554 Fax (831) 757-2226

# SCOPE OF WORK

ADA Upgrade to Restrooms

## PROJECT DATA:

OCCUPANCY GROUP TYPE OF CONSTRUCTION ..

EXISTING BUILDING AREAS (NO CHANGES)

# CODE COMPLIANCE


ALL CONSTRUCTION SHALL CONFORM WITH FOLLOWING: 2016 California Building Code 2016 California Plumbing Code 2016 California Electrical Code

2016 California Energy Code 2016 California Fire Code 2016 California Energy Efficiency Standards

MANEUVERING I


CLEARANCE

ALONG WITH ANY OTHER LOCAL AND STATE LAWS AND REGULATIONS.

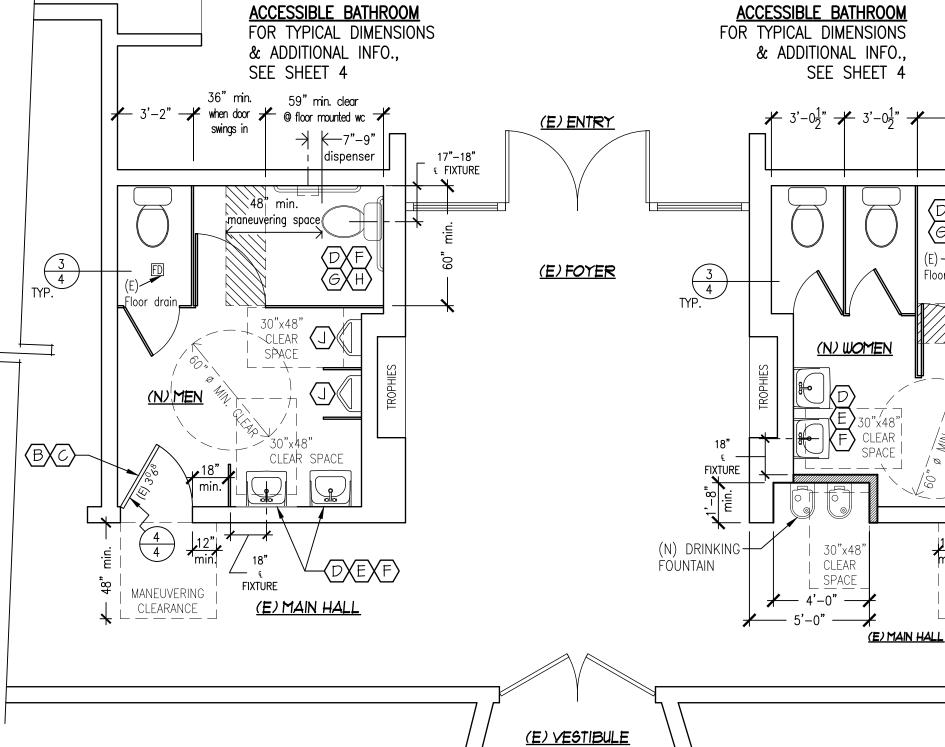

PROPOSED FLOOR PLAN

SC: 1/4"=1'-0"

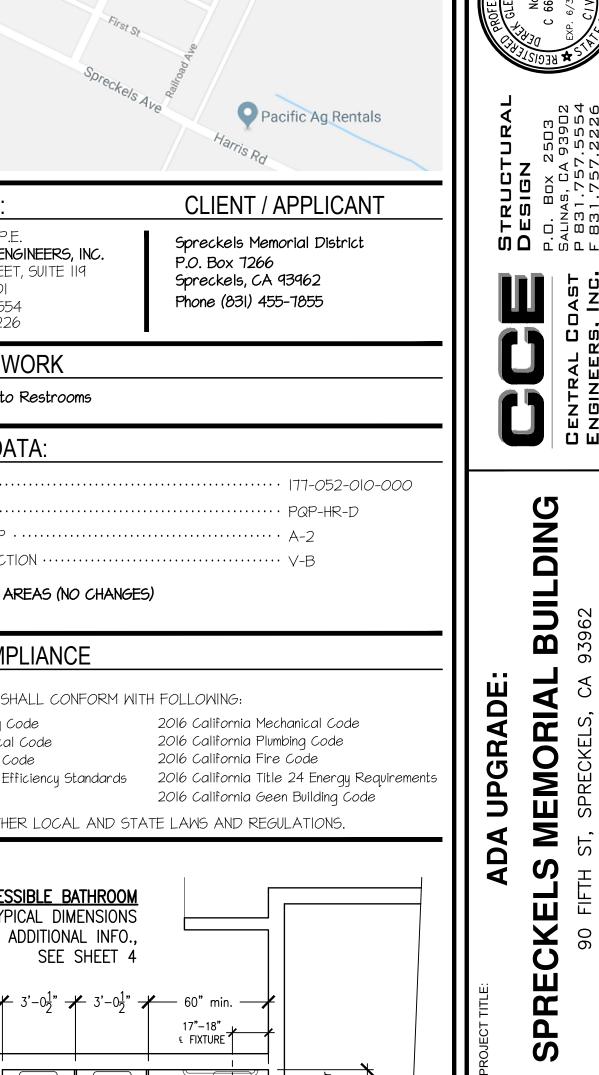

REVISIONS

COVER SP & SITE PLA EXISTING JOB No. CCE-17-103

1/25/2018 DATE: AS NOTED

DRAWN BY: Victor Ruiz

OF SHEETS

SHEET No.:

#### **GENERAL ELECTRICAL NOTES:**

- 1. ALL ELECTRICAL WORK SHALL MEET THE REQUIREMENTS OF THE LATEST ADOPTED NATIONAL ELECTRICAL CODE. THE CALIFORNIA ELECTRICAL CODE AND THE REGULATIONS AND ORDINANCES OF THE AUTHORITY HAVING JURISDICTION.
- 2. ELECTRICIAN TO CONDUCT AN ON-SITE WALK THROUGH WITH OWNERS TO DETERMINE THE FINAL LOCATIONS FOR RECEPTACLE, FIXTURES, PHONES, CABLE, STEREO, SECURITY, DATA LINES, ETC.
- 3. A 200 AMP. MAIN ELECTRICAL PANEL REQUIRED (CEC 230.79)
- 4. MAIN ELECTRICAL SERVICE SHALL BE GROUNDED BY THE UFER-GROUNDING METHOD. WITH A CONCRETE-ENCASED-ELECTRODE PER NEC.
- 5. PLUMBING PIPELINES UTILIZED AS AN ELECTRICAL GROUND ARE PROHIBITED.
- 6. DO NOT RECESS ELECTRICAL PANEL (MAIN OR SUB PANEL) INTO THE 5/8" TYPE 'X' GYP. BD. UNLESS NOTED AND FULLY DETAILED AS FIRE RESISTIVE ASSEMBLY AROUND AND BEHIND THE PANEL. (FULL BLOCK AROUND AND INSTALL FIRE-RATED GYP. BD. BEHIND ELECTRICAL) PANEL PER CBC.
- 7. RELATING TO ALL ELECTRICAL WORK. THE ELECTRICAL CONTRACTOR SHALL OBTAIN A CERTIFICATION OF APPROVAL AS REQUIRED BY THE ORDINANCES OF THE AUTHORITIES HAVING JURISDICTION AND SUBMIT TO THE COUNTY ENGINEER, BEFORE FINAL ACCEPTANCE OF THE ELECTRICAL WORK.
- 8. ALL 125-VOLT. 15- AND 20- AMPERE RECEPTACLE OUTLETS SHALL BE LISTED TAMPER RESISTANT RECEPTACLES. (CEC 406.12)
- 9. ALL APPLIANCES MUST COMPLY WITH THE STATE OF CALIFORNIA BUILDING ENERGY EFFICIENCY STANDARD.
- 10. VERIFY LOCATION OF ALL OUTLETS WITH OWNER PRIOR TO ROUGH-IN.
- 11. CONTRACTOR SHALL VERIFY THE LOCATION OF ALL, PANELS, OUTLET BOXES, ETC. AND COORDINATE THEIR INSTALLATIONS WITH THE OTHER TRADES PRIOR TO STARTING ANY WORK. SEE APPROPRIATE ARCHITECTURAL, STRUCTURAL, PLUMBING, MECHANICAL AND ELECTRICAL DRAWINGS.
- 12. CONTRACTOR SHALL OBTAIN ELECTRICAL DRAWINGS AND VERIFY ALL WORK REQUIRED FOR POWER AND CONTROL OF ELECTRICAL EQUIPMENT. FURNISH AND INSTALL LINE AND LOW VOLTAGE WIRING, MATERIAL AND EQUIPMENT REQUIRED TO PROVIDE COMPLETE INTERLOCKING AND OPERATION OF THE ELECTRICAL SYSTEM.
- 13. THE ELECTRICAL CONTRACTOR SHALL ARRANGE FOR INSPECTIONS, TESTS AND GIVE REQUIRED NOTICES TO UTILITY REPRESENTATIVES AND BUILDING INSPECTORS RELATING TO ELECTRICAL WORK. THE ELECTRICAL CONTRACTOR SHALL OBTAIN A CERTIFICATE OF APPROVAL AS REQUIRED. ORDINANCES OF AUTHORITIES HAVING JURISDICTION.
- 14. THE ELECTRICAL CONTRACTOR SHALL VISIT THE JOB SITE AND FULLY ACQUAINT HIMSELF/HERSELF WITH EXISTING PROJECT CONDITIONS AND VERIFY SERVICES CONNECTIONS INCLUDING ALL NECESSARY PULL BOXES THAT MAY BE REQUIRED BY CODE TO ACHIEVE THE DESIRED ARRANGEMENT, WHETHER SHOWN ON THE ELECTRICAL DRAWINGS OR NOT; BUT REQUIRED TO MAKE A COMPLETE AND APPROVED INSTALLATION.
- 15. ELECTRICAL DRAWINGS ARE DIAGRAMMATIC AND INDICATE THE LOCATION OF OUTLETS AND EQUIPMENT WITH THE CIRCUIT ARRANGEMENT OF THE REQUIRED WIRING AND DO NOT NECESSARILY INDICATING THE ACTUAL ROUTES. THE DRAWINGS SHALL BE FOLLOWED AS CLOSELY AS PROPER COORDINATION WITH THE WORK OF THEIR TRADES AND THE AVAILABLE SPACES PERMIT.
- 16. THE BUILDER/CONTRACTOR TO PROVIDE THE OWNER AND THE COUNTY BUILDING DIVISION WITH A COPY OF THE CF-6R INSTALLATION CERTIFICATE AT THE TIME OF FINAL INSPECTING
- 17. REMOVE ALL DIRT. OIL OR GREASE FROM EQUIPMENT, CLEAN AND POLISH LIGHTING FIXTURES. AND TRIMS.
- 18. SITE SHALL BE LEFT BROOM CLEAN AFTER COMPLETE OF WORK.
- 19. ALL ELECTRICAL MATERIALS SHALL BE NEW AND SHALL CONFORM TO THE REQUIREMENTS OF AND BE LISTED BY "UNDERWRITERS LABORATORIES INC." WHERE SUCH LISTING IS APPLICABLE.
- 20. PROVIDE NYLON PULL LINES IN ALL EMPTY CONDUITS STUBS & TAG AS THE USAGE (IE, TELEPHONE", ETC.) THE EXACT LOCATION & DEPTH OF ALL UNDERGROUND CONDUIT STUBS SHALL BE CLEARLY NOTED ON THE AS-BUILT PLANS.
- 21. ALL CUTTING AND PATCHING FOR ELECTRICAL WORK (INSTALLATION FOR NEW AND DEMOLITION OF EXISTING) IS THE RESPONSIBILITY OF THE ELECTRICAL CONTRACTOR.
- 22. HOLES IN EXISTING SURFACES SHALL BE HELD TO THE MINIMUM REQUIRED FOR WORK TO BE INSTALLED OR REMOVED.
- 23. PATCHING SHALL BE AS REQUIRED TO MATCH EXISTING ADJACENT SURFACES. ALL JOINTS SHALL BE TIGHT, EVEN AND SMOOTH. PATCHING OF FINISHES (PANELING, PAPERING, PAINTING THIN COAT PLASTER, ETC.) IS BY OTHERS.

### **OUTLET BOXES:**

- 1. WALL AND CEILING MOUNTED LIGHT FIXTURES SHALL BE INSTALLED AT, AND CONNECTED VIA INDIVIDUAL OUTLETS BOXESS UNLESS SPECIALLY NOTED OR INDICATED OTHERWISE.
- 2. OUTLET BOXES IN WALL AND CEILINGS OF PLASTER, DRYWALL OR THE PLASTERBOARD SHALL BE INSTALLED SUCH THAT THERE ARE NO GAPS OR OPENINGS BETWEEN THE EDGE OF THE BOX AND THE WALL OR CEILING MATERIAL. PATCH WALLS AS REQUIRED TO CLOSE GAPS.
- 3. BATHROOM ELECTRICAL OUTLETS SHALL BE SUPPLIED BY AT LEAST ONE 20-AMPERE BRANCH CIRCUIT. THE CIRCUITS SHALL HAVE NO OTHER ELECTRICAL OUTLETS PER NEC 250-52
- 4. HVAC EQUIPMENT TO BE SERVED BY A DEDICATED AND INDIVIDUAL BRANCH CIRCUIT.
- 5. GROUPS OF OUTLETS (RECEPTACLES, TELEPHONE, ETC) SHOULD BE CLUSTERED TOGETHER-PROVIDE BLOCKING AS REQUIRED.
- 6. STAGGER ALL OUTLETS SHOWN BACK-TO-BACK. THRU WALL OUTLETS ARE NOT PERMITTED, U.O.N.

# **RECEPTACLES:**

- 1. ALL CONVENIENCE OUTLETS SHALL BE MOUNTED 16" FROM FINISH FLOOR UNLESS OTHERWISE NOTED.
- 2. A MIN. HORIZONTAL SEPARATION OF 24 INCHES IS REQUIRED FOR ELECTRICAL BOXES ON OPPOSITE SIDE OF FIRE WALL (SWITCHES AND OUTLET BOXES) PER CBC 709.7
- 13. BATHROOM RECEPTACLE OUTLETS SHALL BE SUPPLIED BY AT LEAST ONE 20 AMP CIRCUIT. SUCH CIRCUITS SHALL HAVE NO OTHER OUTLETS. ARTICLE 210-11(C)(3), CEC.

#### GROUND-FAULT CIRCUIT-INTERRUPTER PROTECTION FOR PERSONNEL. [CEC210.8]

- GROUND-FAULT CIRCUIT-INTERRUPTER PROTECTION FOR PERSONNEL SHALL BE PROVIDED AS REQUIRED IN 210.8(A) THROUGH (D). THE GROUND-FAULT CIRCUIT-INTERRUPTER SHALL BE INSTALLED IN A READILY ACCESSIBLE LOCATION.
- ALL 125-volt, SINGLE-PHASE, 15- AND 20-ampere RECEPTACLES INSTALLED IN THE LOCATIONS SPECIFIED IN 210.8(B)(1) THROUGH (8) SHALL HAVE GROUND-FAULT CIRCUIT-INTERRUPTER PROTECTION FOR PERSONNEL.
- (1) BATHROOMS
- (2) KITCHENS
- (3) ROOFTOPS
- (4) OUTDOORS (5) SINKS - WHERE RECEPTACLES ARE INSTALLED WITHIN 6 feet OF THE OUTSIDE EDGE OF
- THE SINK. (6) INDOOR WET LOCATIONS
- (7) LOCKER ROOMS WITH ASSOCIATED SHOWERING FACILITIES.
- (8) GARAGEM SERVICE BAYS, AND SIMILAR AREAS OTHER THAN VEHICLE EXHIBITION HALLS AND

#### RECEPTACLES IN DAMP OR WET LOCATIONS. [CEC 406.9]

#### (A) DAMP LOCATIONS:

A RECEPTACLE INSTALLED OUTDOORS IN A LOCATION PROTECTED FROM THE WEATHER OR IN OTHER DAMP LOCATIONS SHALL HAVE AN ENCLOSURE FOR THE RECEPTACLE THAT IS WEATHERPROOF WHEN THE RECEPTACLE IS COVERED (ATTACHMENT PLUG CAP NOT INSERTED AND RECEPTACLE COVERS CLOSED)

AN INSTALLATION SUITABLE FOR WET LOCATIONS SHALL ALSO BE CONSIDERED SUITABLE FOR DAMP LOCATIONS.

A RECEPTACLE SHALL BE CONSIDERED TO BE IN A LOCATION PROTECTED FROM THE WEATHER WHERE LOCATED UNDER ROOFED PORCHES, CANOPIES, MARQUEES, AND THE LIKE, AND WILL NOT BE SUBJECTED TO A BEATING RAIN OR WATER RUNOFF. ALL 15-AND 20-AMPERE, 125- ANS-D 250-VOLT NONLOCKING RECEPTACLES SHALL BE A LISTED WEATHER-RESISTANT TYPE.

15- AND 20-AMPERE, 125- AND 250-VOLT RECEPTACLES INSTALLED O UTDOORS IN A WET LOCATION SHALL HAVE AN ENCLOSURE THAT IS WEATHERPROOF WHETHER OR NOT THE ATTACHMENT PLUG CAP IS INSERTED. ALL 15- AND 20-AMPERE, 125- ANS-D 250-VOLT NONLOCKING RECEPTACLES SHALL BE A LISTED WEATHER-RESISTANT TYPE.

#### LIGHTING:

- 1. PROVIDE ONE SWITCHED LIGHT FIXTURE OR SWITCH—CONTROLLED OUTLET IN HALLWAYS. STAIRWAYS, ATTACHED GARAGES AND DETACHED GARAGES WITH ELECTRICITY.
- 7. ALL LUMINAIRES AND THEIR SWITCHING SHALL COMPLY WITH THE 2016 ENERGY EFFICIENCY STANDARDS OF THE CEC.
  - A- ALL PERMANENTLY INSTALLED LUMINAIRES MUST BE HIGH EFFICACY.
- B- ALL FIXTURES IN GARAGES. LAUNDRY ROOMS, BATHROOMS AND UTILITY ROOMS MUST BE CONTROLLED BY A VACANCY SENSOR OR DIMMER. AT LEAST ONE LUMINAIRE IN EACH ROOM MUST BE CONTROLLED BY VACANCY SENSORS
- 9. INSTALL BLOCKING FOR FIXTURE SUPPORTS WHERE REQUIRED. WHERE CONFLICT WITH JOISTS PATTERN OCCURS, COORDINATE WITH GENERAL CONTRACTOR TO HEAD OFF JOISTS AS REQUIRED.

#### **KEY NOTES**

PROVIDE WALL MOUNTED OCCUPANCY SENSOR/WALL SWITCH, ACUITY CONTROLS SENSOR SWITH Series WSD PDT WH IN TOILET ROOM(S). SWITCH SHALL CONTROL FAN AND LIGHT.

### LIGHT FIXTURE SCHEDULE

TAG	SYMBOL	DESCRIPTION	MANUFACTURER	VOLTS	WATT	QTY.	PART NUMBER	NOTES
A		INDUSTRIAL LED LINEAR BAY 4 ft. (4ILED-LD4-5)	Metalux 4 ft.	120	35		(4ILED-LD4-5)	
В								
C								

### EXHAUST FAN SCHEDULE

SYMBOL	LOCATION	CFM	ESP	SONES	MO W	TOR V/Hz	FAN RPM	MANUFACTURER
	CEILING	150	0.1"	0.3	28.4	120/60	691	PANASONIC FV-15VQ5

#### **ELECTRICAL SYMBOLS**

DUPLEX OUTLET / GROUND FAULT INTERRUPTER

POWER SWITCH

POWER SWITCH W/ VACANCY SENSOR

EXHAUST FAN (SEE SCHEDULE)

# FIXTURE/EQUIPMENT SCHEDULE

- ADA COMPLIANT WATER CLOSET  $\frac{7}{4}$ ELONGATE BOWL.
- EXTRA HEAVE DUTY, OPEN FRONT, NO COVER; TOILET SEAT. • SLOAN OPTIMA FLUSHOMETER, SENSOR ACTIVATED; 1.28 GPF.
- ADA COMPLIANT URINAL 4 WALL-MOUNTED; WATER-LESS
- ADA COMPLIANT LAVATORY \( \) • TOUCHLESS FAUCET; 0.5 gal/min AT 60psi
- PARTITIONS: MARLIIE COLOR: 601 TOPAZ PARTITIONS: MARLITE HIGH DENSITY POLIMER (H.D.P.)
- DRINKING FOUNTAIN WALL MOUNT.
  ELKAY HEAVY DUTY 14 GAUGE MODEL EHWM217C
- 6 FLOOR AND WALL BASE. WOW.

  12"x12" SQUARE. SEE DETAIL

  3
  4 FLOOR AND WALL BASE: IVORY PORCELAIN FLOOR TILE
- WALLS: 4'-0" HEIGHT BEIGE PORCELAIN WALL TILE 6"x6" SQUARE. WALLS AND CEILINGS: MILDEW-RESISTANT PAINT (BENJAMIN MOORE AURA INTERIOR SEMIGLOSS-528) SEE DETAIL 3
- TOWEL DISPENSER: GEORGIA—PACIFIC Item# 59460 AUTOMATED TOUCHLESS TOWEL DISPENSER
- TISSUE DISPENSER: COMPACT Side—by—Side Item# 56783 DOUBLE ROLL CORELESS TISSUE DISPENSER
- (10) SOAP DISPENSER: DEB Item# 96436 FOAM BLUE SOAP DISPENSER
- SEAT COVER DISPENSER: Item# SCD50CH CHROME SEAT COVER
- METERED AIR FRESHENER DISPENSER: AFDN AEROSOL DEODORANT
- CHANGING TABLE: KOALA KARE Item# KB101-00 VERTICAL WALL

MOUNTED BABY CHANGING TABLE

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REVISIONS



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ELECTRIC ELECTRIC FIXTURE

JOB No. CCE-17-103


1/25/2018

AS NOTED DRAWN BY: Victor Ruiz

DATE:

SHEET No.:


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FIXTURE / EQUIPMENT PLAN SC: 1/4"=1'-0"
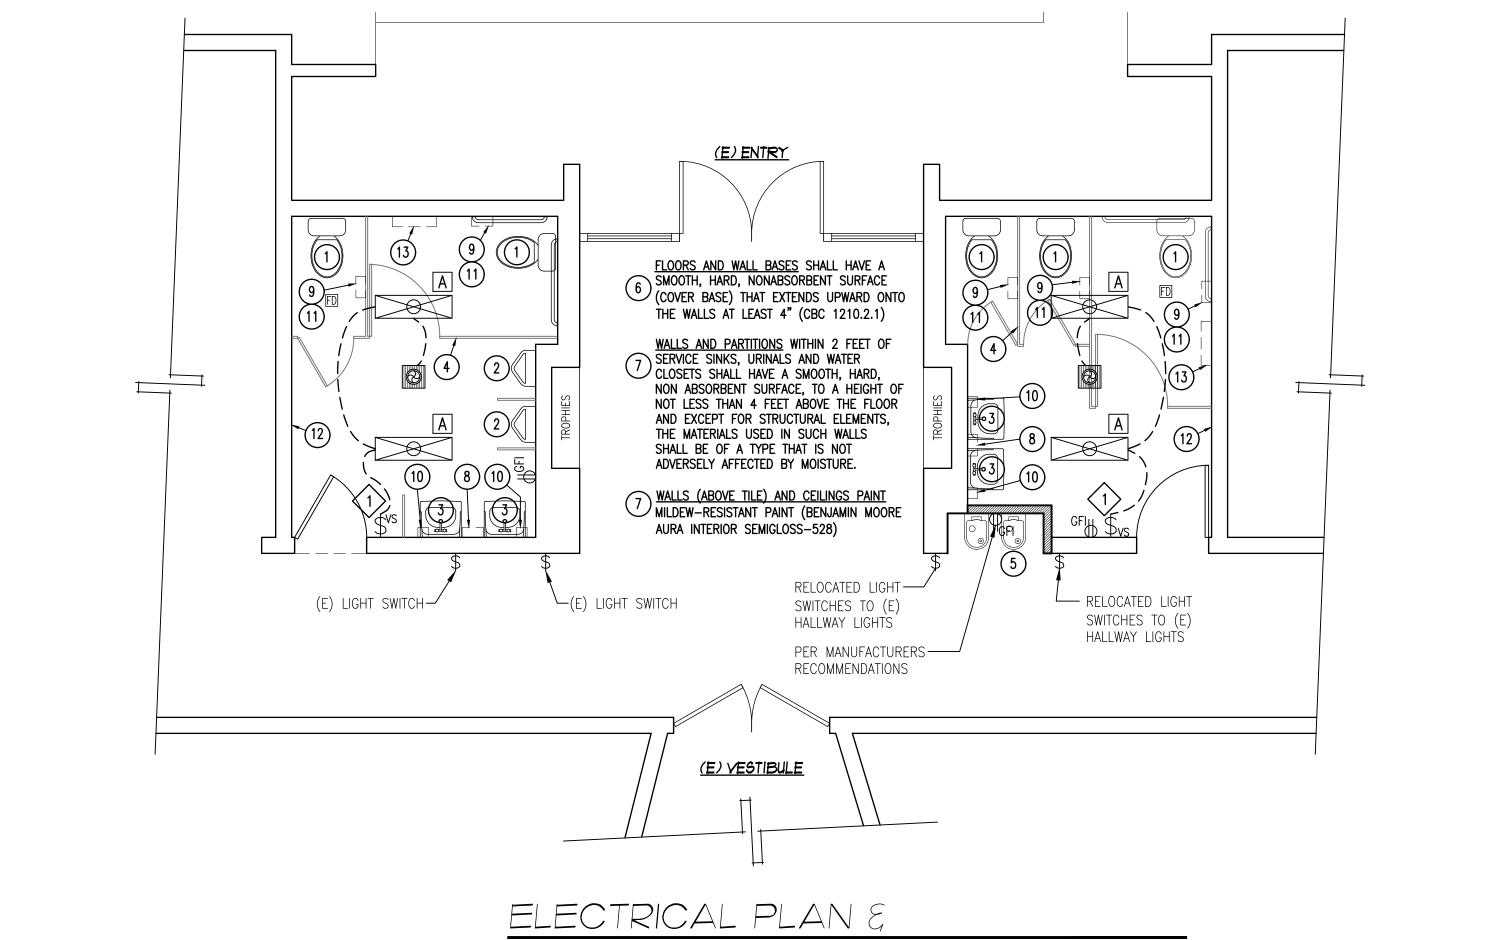
#### PLUMBING NOTES

- 1. SEE ARCHITECTURAL PLANS FOR EXACT PLAN LOCATIONS AND MOUNTING HEIGHTS OF PLUMBING FIXTURES.
- 2. SEE STRUCTURAL DRAWINGS FOR FRAMING LAYOUT AND DETAILS. CONTRACTOR SHALL COORDINATE PRIOR TO START OF FRAMING ANY SPECIAL JOIST SPACING OR BLOCKOUT CONDITIONS REQUIRED FOR PLUMBING WORK.
- 3. HORIZONTAL PIPING SHOWN THIS PLAN TYPICALLY LOCATED WITHIN FLOOR JOIST SPACE UNLESS OTHERWISE NOTED.
- 4. COORDINATE EXACT LAYOUT OF ALL PLUMBING PIPING WITH HVAC DUCTWORK AND DESIGN BUILDING FIRE SPRINKLER CONTRACTOR PRIOR TO INSTALLATION.
- 5. VENT PIPES SHALL BE CAST IRON, GALVANIZED STEEL, GALVANIZED WROUGHT IRON, COPPER, BRASS, SCHEDULE 40 PVC DWV OR OTHER MATERIAL APPROVED FOR USE BY THE UPC, AND INSTALLED PER CODE REGULATIONS.
- 6. FLASH VENT PIPING THROUGH ROOF WITH 17 GA. OR HEAVIER GALVANIZED FLASHING. MAKE WATER-TIGHT WITH BLACK FIBROUS MASTIC. EXTEND FLASHING INTO ROOFING FELT 12 INCHES FROM PIPE MINIMUM.
- 7. WATER PIPING SHALL BE BRASS, COPPER, CAST IRON, GALVANIZED MALLEABLE IRON, GALVANIZED WROUGHT IRON, GALVANIZED STEEL, OR OTHER CODE APPROVED MATERIAL, AND INSTALLED PER CODE REQUIREMENTS.
- 8. WATER LINES SHALL BE DISINFECTED WITH CHLORINE SOLUTION.
- 9. PROVIDE ACCESS PANEL (12" X 12" MIN.) OR UTILITY SPACE FOR ALL PLUMBING FIXTURES HAVING CONCEALED SLIP-JOINT CONNECTIONS.
- 10. WATER PIPING SHALL NOT BE INSTALLED IN OR UNDER A CONCRETE SLAB WITHIN THE BUILDING WITHOUT OBTAINING SPECIAL APPROVAL FROM THE BUILDING OFFICIAL.
- 11. NO WATER, SOIL, OR WASTE PIPE SHALL BE INSTALLED OR PERMITTED OUTSIDE OF A BUILDING OR IN AN EXTERIOR WALL UNLESS, WHERE NECESSARY, ADEQUATE PROVISION IS MADE TO PROTECT SUCH PIPE FROM FREEZING. (CPC 313.6)
- 12. WATER HEATER CONTROL SHALL LIMIT THE OUTLET TEMPERATURE TO 110 DEGREES FOR PUBLIC LAVATORIES [113.19(c) 3 CEnC]



FIXTURE CONNECTION						
DESCRIPTION		М	TDAD	COMMENT		
DESCRIPTION	W	٧	CW	HW	TRAP	COMMEN
WATER CLOSET	4"	2"	1"		4"	
URINAL	2"	1-1/2"	3/4"		2"	
LAVATORY	2"	1-1/2"	1/2"	1/2"	2"	
DRINKING FOUNTAIN	2"	1-1/2"	1/2"		2"	

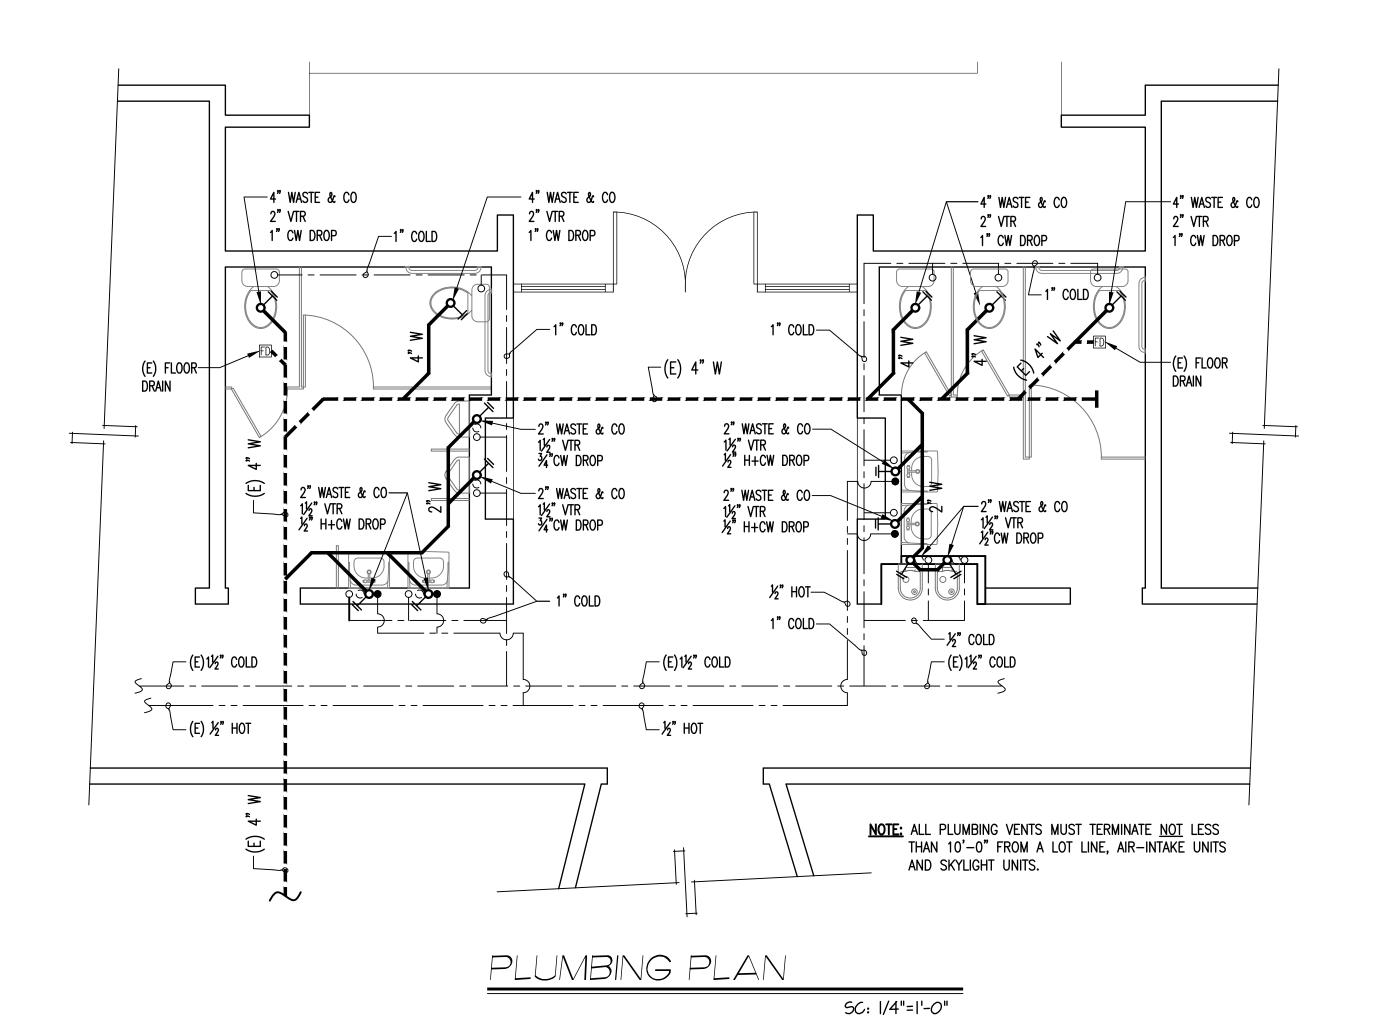
- 1. NOT TO EXCEED 1.28 GAL PER FLUSH
- 2. INDIVIDUAL CONTROL VALVES OF THE PRESSURE BALANCE OR THERMOSTATIC MIXING
  - VALVE TYPE SHALL BE PROVIDED

PIPE INSULATION THICKNESS TABLE									
	INSULATION THICKNESS REQUIRED								
PIPE DIAMETER	SPACE HEATING 105°-140°	SPACE HEATING 141°-200°	SERVICE WATER HEATING 105° AND ABOVE	SPACE COOLING 40°-60°					
RUNOUTS UP TO 2"	1/2"	1/2"	1"	1/2"					
1/2"-2"	1"	1-1/2"	1"	1/2"					
2-1/2"-4"	1"	1-1/2"	1-1/2"	1"					

- 1. ALL REQUIREMENTS PER MANDATORY MEASURE OF THE CALIFORNIA ENERGY CODE SECTION 120.3
- 2. INSULATION THICKNESS SHOWN ARE TYPICAL TO FIBERGLASS OR FOAM TYPE
- RUNOUTS ARE DEFINED AS BEING LESS THAN TWO INCHES IN DIAMETER, LESS THAN 12 FEET LONG AND CONNECTED TO FIXTURES OR INDIVIDUAL TERMINAL UNITS

<u>LEG</u>	<u>END</u>		
		INDICATES	COLD WATER LINE
		INDICATES	HOT WATER LINE
		INDICATES	WASTE LINE
		INDICATES	(E) WASTE LINE
•	$\vdash$	INDICATES	CLEAN-OUT (CO)

**REVISIONS** 

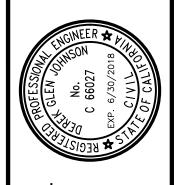

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SPRECKELS MEN

GRADE

ADA UPO

JOB No. CCE-17-103 1/25/2018

